


GENERAL NOTES:


- A. CONTRACTOR SHALL FIELD VERIFY AND COORDINATE LOCATION OF NEW EQUIPMENT, PIPING, VALVES, DUCTWORK, ELECTRICAL AND CONTROL WIRING WITH EXISTING PRIOR TO INSTALLATION. ITEMS SHOWN ON THIS PLAN ARE APPROXIMATE.
- B. REFER TO LEGEND SHEET FOR GENERAL ABBREVIATIONS AND SYMBOLS.
- C. REFER TO CHILLER PIPING SCHEMATIC FOR ALL VALVES. FOR CLARITY, ALL VALVES ARE NOT SHOWN ON THIS PLAN.
- D. INSTALL ALL EQUIPMENT AND COMPONENTS PER
 MANUFACTURER'S RECOMMENDATION WITH CLEARANCE FOR
 MAINTENANCE AND OPERATION OF EQUIPMENT. PROVIDE
 ACCESS CLEARANCE AT ALL LOCATIONS OF VALVES,
 STRAINERS, INSTRUMENTATION, AND EQUIPMENT AS
 REQUIRED BY MANUFACTURER FOR EASE OF MAINTENANCE.

KEYNOTES:

- 1 VENTILATION SYSTEM TO BE PROVIDED UNDER SEPARATE WMATA CONTRACT. FANS AND DUCTWORK SHOWN FOR REFERENCE ONLY. REFER TO WMATA CONTRACT FQ14114.
- 2 PROVIDE 1½" CWHS AND CHWR BRANCH TO FCU-1. WET TAP INTO EXISTING 8" CHWS AND CHWR PIPING.
- 3 EXISTING REFRIGERANT MONITORING PANEL. SHOWN HERE FOR REFERENCE.
- PROVIDE AND INSTALL NEW EYEWASH, UTILITY SINK, FAUCET, AND INSTANTANEOUS WATER HEATER, INCLUDING PIPING, WIRING, AND SUPPORTS. WATER SUPPLY SHALL BE FIELD ROUTED TO CONNECT UPSTREAM OF THE EXISTING MAKE—UP WATER BACKFLOW PREVENTERS. PROVIDE INLINE ISOLATION VALVE, STRAINER, AND REDUCED PRESSURE TYPE BACKFLOW PREVENTER AT AN ACCESSIBLE LOCATION. FIELD ROUTE UTILITY SINK DRAINAGE PIPING ALONG FLOOR SLAB TO NEARBY FLOOR DRAIN. PROVIDE PIPING ALONG FLOOR SLAB WITH NON—SLIP PIPE COVER WHERE THERE IS A TRIP HAZARD. EYEWASH DRAINAGE SHALL BE STRAIGHT TO FLOOR. REFER TO DETAIL 1 ON DRAWING M—502.
- 5 PROVIDE AND INSTALL NEW SPACE THERMOSTAT AND INTEGRATE WITH NEW FCU-1.
- PROVIDE AND INSTALL NEW UNIT HEATER INCLUDING WIRING, RE-USE EXISTING SUPPORT, AND WALL-MOUNTED THERMOSTAT.
- PROVIDE AND INSTALL NEW THERMOSTATICALLY CONTROLLED FAN COIL UNIT (FCU-1) INCLUDING PIPING, VALVES, WIRING, AND SUPPORTS. CHWS TO THE UNIT SHALL BE TAPPED FROM THE CHWS MAIN AS INDICATED; CHWR SHALL BE TAPPED INTO THE CHWR MAIN AS INDICATED. CHWS AND CHWR PIPING SHALL BE FIELD ROUTED. UNIT SHALL BE MOUNTED AT A MINIMUM 8'-0" AFF. FIELD COORDINATE FINAL MOUNTING ELEVATION WITH OTHER TRADES.
- 8 PRIMARY CONDENSATE DRAINAGE FROM FCU-1 SHALL BE FIELD ROUTED DOWN TO AND ALONG FLOOR SLAB TO A NEARBY FLOOR DRAIN. OVERFLOW CONDENSATE DRAINAGE FROM FCU-1 SHALL BE FIELD ROUTED TO DISCHARGE AT VISIBLE LOCATION. DRAINAGE RISERS DOWN TO FLOOR SHALL BE MOUNTED FLUSH WITH STRUCTURAL COLUMN(S). PROVIDE PIPING ALONG FLOOR SLAB WITH NON-SLIP PIPE COVER WHERE THERE IS A TRIP HAZARD.

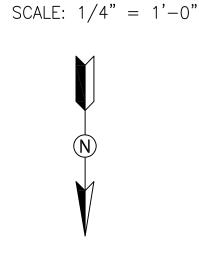

A Gannett Fleming/Parsons
JOINT VENTURE

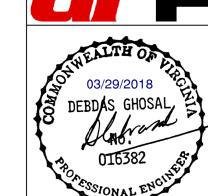

		REFERENCE DRAWINGS	REVISIONS					
DESIGNED M. MCDONNELL 01/26/18	NUMBER	TITLE	DATE	NUM	DESCRIPTION			
DESIGNED M. MCDONNELL 01/26/18 DATE			03/30/2018	0	FINAL CONTRACT DRAWINGS			
DRAWN M. MCDONNELL 01/26/18								
DATE CHECKED D. GHOSAL 03/23/18								
DATE								

MECHANICAL FLOOR PLAN - NEW WORK

CWPK2-M-103

WASHINGTON METROPOLITAN AREA TRANSIT AUTHORITY

DEPARTMENT OF DESIGN AND CONSTRUCTION SERVICES OFFICE OF INFRASTRUCTURE RENEWAL PROGRAM GROUP

APPROVED Mark H. Magnusser 03/2018

MARK MAGNUSSEN DATE

MANAGER, ENV. PLANNING AND COMP


APPROVED 03/2018

GRAHAM SPILLER

GFP DEPUTY PROGRAM MANAGER

REPLACEMENT OF CHILLERS
AND COOLING TOWER ACCESSORIES AT EIGHT METRO-RAIL STATIONS
CWPK2 - BALLSTON (K04)
MECHANICAL PLAN - NEW WORK

			MECHANICALFI	LAIN - INL VV VVOINN	
_	M NO.	CONTRACT NO.	SCALE	DRAWING NO.	SHEET NO.
	M1304	FQ-18102	1/4" = 1'-0"	CWPK2-M-103	153 of 173

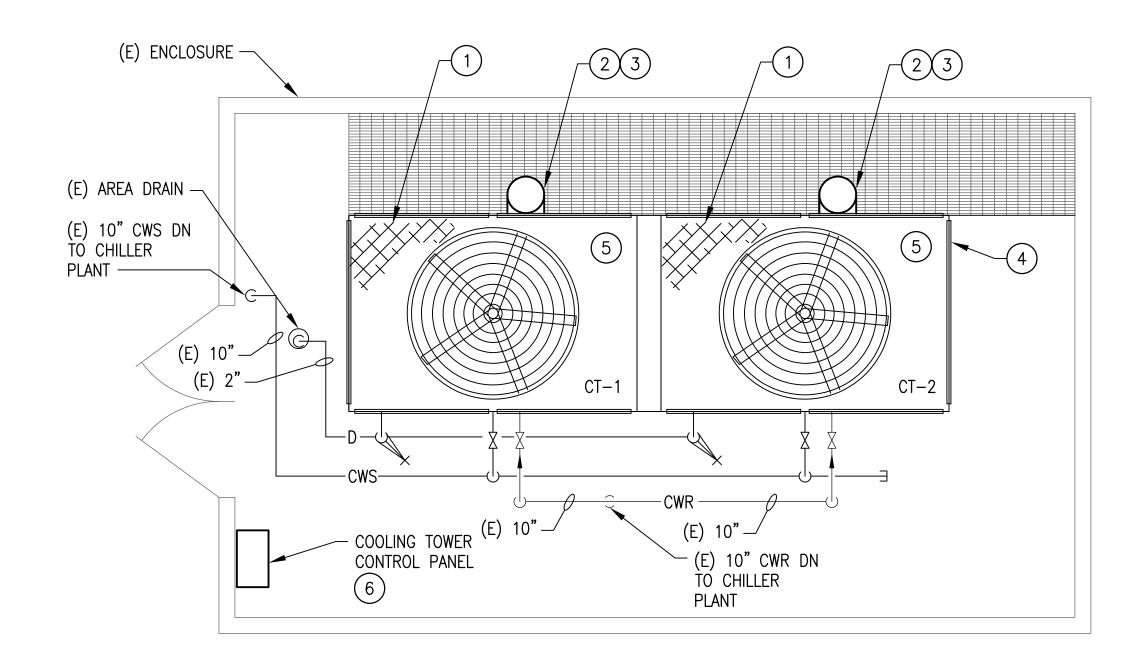

1 MECHANICAL PLAN - NEW WORK
CWPK2-M-104


SCALE: 1/4" = 1'-0"


GENERAL NOTES:

- A. CONTRACTOR SHALL FIELD VERIFY EXACT LOCATION AND QUANTITIES OF EQUIPMENT, PIPING, VALVES, DUCTWORK, ELECTRICAL AND CONTROL WIRING PRIOR TO DEMOLITION. ITEMS SHOWN ON THIS PLAN ARE APPROXIMATE.
- B. REFER TO LEGEND SHEET FOR GENERAL ABBREVIATIONS AND SYMBOLS.

KEYNOTES:

- 1 PROVIDE AND INSTALL NEW PLASTIC FILL IN THE COOLING TOWER. COORDINATE WITH COOLING TOWER MANUFACTURER FOR EXACT PART. THE NEW FILL DIMENSION AND TYPE SHALL MATCH EXISTING.
- 2 PROVIDE AND INSTALL NEW DIRECT DRIVE FAN MOTOR, DRIVE ASSEMBLY, AND MOUNTING HARDWARE. FAN MOTOR SHALL BE INVERTER DUTY RATED. COORDINATE WITH COOLING TOWER MANUFACTURER FOR EXACT PARTS.
- 3 PROVIDE AND INSTALL NEW VARIABLE FREQUENCY DRIVE CONTROLLER FOR COOLING TOWER FAN. VFD SHALL BE LOCATED INSIDE A NEMA 4X ENCLOSURE.
- 4 PROVIDE AND INSTALL NEW LOUVER GRILLES ON COOLING TOWER. COORDINATE WITH COOLING TOWER MANUFACTURER FOR EXACT PART. THE LOUVER DIMENSION SHALL MATCH EXISTING.
- 5 PROVIDE NEW SUMP PUMP. FIELD COORDINATE EXACT LOCATION OF SUMP PUMP.
- (6) PROVIDE AND INSTALL NEW DISCONNECT AND CONTROLS.

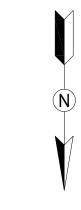

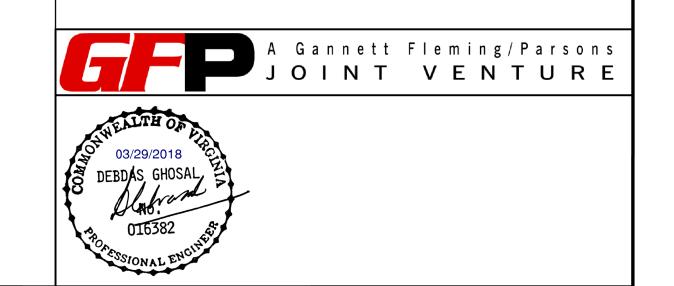

ı					REFERENCE DRAWINGS			REVISIONS	
ı	55000055	M. MCDONNELL 01/20	6/18	NUMBER	TITLE	DATE	NUM	DESCRIPTION	<u> </u>
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WASHINGTON METROPOLITAN AREA TRANSIT AUTHORITY


DEPARTMENT OF DESIGN AND CONSTRUCTION SERVICES OFFICE OF INFRASTRUCTURE RENEWAL PROGRAM GROUP

APPROVED Mark WAGNUSSEN DATE GRAHAM SPILLI MANAGER, ENV. PLANNING AND COMP GFP DEPUTY PI


APPROVED 03/2018 M
GRAHAM SPILLER
GFP DEPUTY PROGRAM MANAGER

REPLACEMENT OF CHILLERS
AND COOLING TOWER ACCESSORIES AT EIGHT METRO-RAIL STATIONS
CWPK2 - BALLSTON (K04)
MECHANICAL PLAN - NEW WORK


			WECHANICAL PL	LAN - NEW WORK	
М	NO.	CONTRACT NO.	SCALE	DRAWING NO.	SHEET NO.
М	1304	FQ-18102	1/4" = 1'-0"	CWPK2-M-104	154 of 173

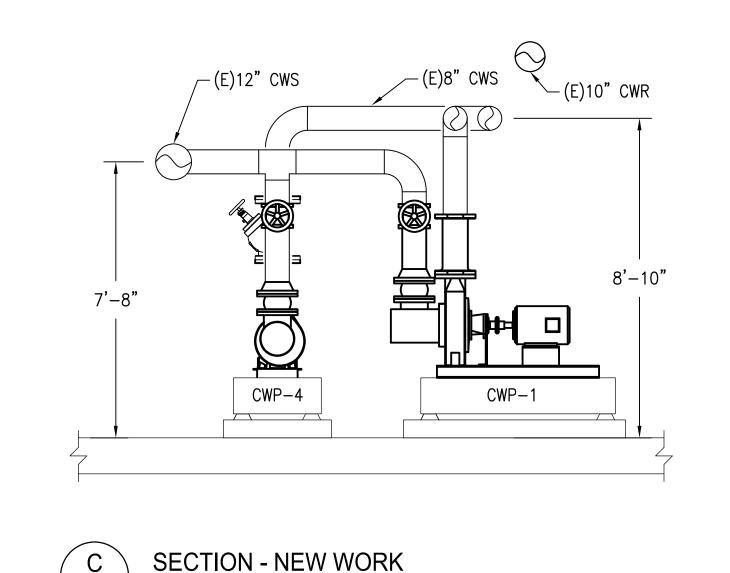

SCALE: 3/8" = 1'-0"

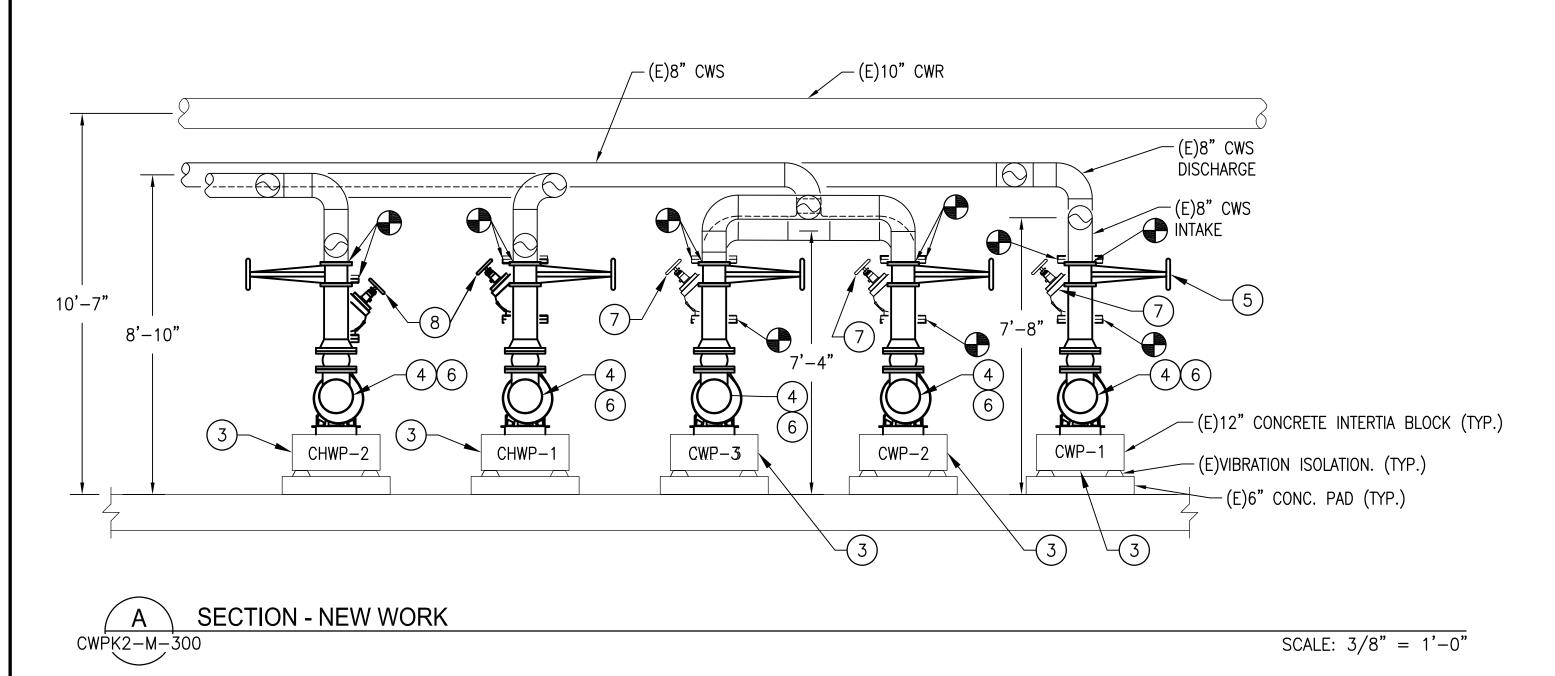

CWPK2-M-300

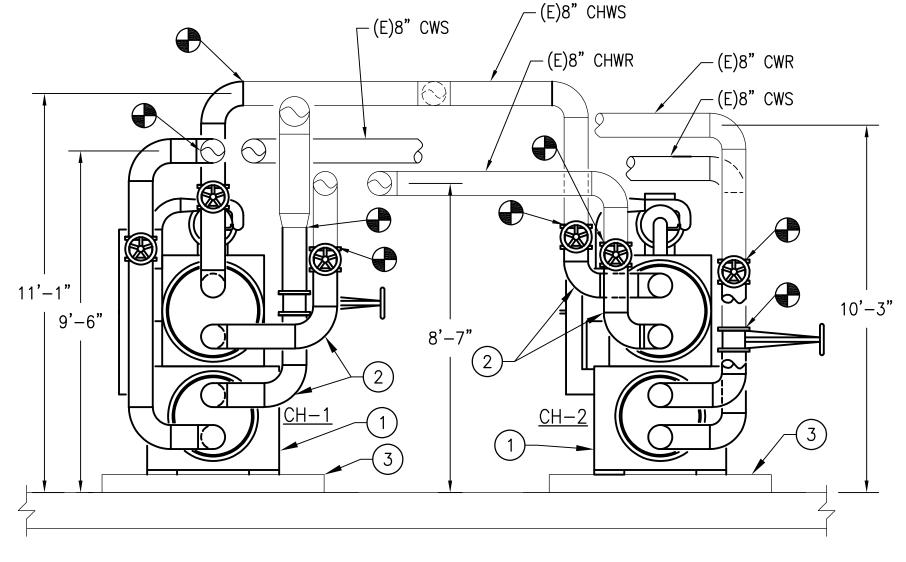


SCALE: 3/8" = 1'-0"

<u>GENERAL NOTES:</u>

- A. CONTRACTOR SHALL FIELD VERIFY AND COORDINATE LOCATION OF NEW EQUIPMENT, PIPING, VALVES, DUCTWORK, ELECTRICAL AND CONTROL WIRING WITH EXISTING PRIOR TO INSTALLATION. ITEMS SHOWN ON THIS PLAN ARE APPROXIMATE.
- B. REFER TO LEGEND SHEET FOR GENERAL ABBREVIATIONS AND SYMBOLS.
- C. REFER TO CHILLER PIPING SCHEMATIC FOR ALL VALVES. FOR CLARITY, ALL VALVES ARE NOT SHOWN ON THIS PLAN.
- D. INSTALL ALL EQUIPMENT AND COMPONENTS PER MANUFACTURER'S RECOMMENDATION WITH CLEARANCE FOR MAINTENANCE AND OPERATION OF EQUIPMENT.
- E. PROVIDE PRESSURE GAUGES AT INTAKE AND DISCHARGE PIPING OF OF EACH PUMP PUMP.
- F. REFER TO STANDARD DETAIL FOR PUMP GENERAL INSTALLATION PER MANUFACTURER'S REQUIREMENT.

KEYNOTES:

- 1) PROVIDE AND INSTALL CHILLER, ANCHOR AND SUPPORT.
- PROVIDE AND INSTALL ALL PIPING, FITTINGS, VALVES, PIPING INSULATION AND INSTRUMENTATION FOR CONNECTION TO CHILLER. PROVIDE A VICTAULIC COUPLING CONNECTION PIECE AT EACH PIPE CONNECTION TO CHILLER FOR EASE OF MAINTENANCE.
- REUSE EXISTING EQUIPMENT PAD, SPRING ISOLATOR AND INERTIA PAD. REPAIR AND MODIFY AS REQUIRED TO FIT NEW INSTALLATION.
- PROVIDE AND INSTALL ALL APPROPRIATE PIPE FITTINGS FOR CONNECTION TO PUMPS.
- 5) PROVIDE OS&Y GATE VALVE FOR SHUTOFF (TYP).
- 6 PROVIDE SUCTION DIFFUSER WITH INTEGRAL STRAINER AT PUMP INTAKE (TYP).
- REUSE EXISTING 8" TRIPLE DUTY VALVE. IF THE TRIPLE DUTY VALVES ARE IN WORKING CONDITION. IF FOUND DEFECTIVE, REPLACE IN KIND. AS SHOWN IN THIS VEIW THE VALVE LOCATED IN PIPING BEHIND PUMP INTAKE PIPING. CONTRACTOR SHALL COORDINATE WITH DEMOLITION WORK.
- 8 PROVIDE NEW 8" TRIPLE DUTY VALVE ON DISCHARGE PIPING. AS SHOWN IN THIS VEIW THE VALVE LOCATED IN PIPING BEHIND PUMP INTAKE PIPING.

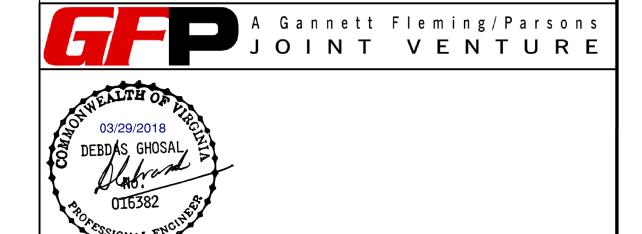

			REFERENCE DRAWINGS			REVISIONS	
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WASHINGTON METROPOLITAN AREA TRANSIT AUTHORITY

CWPK2-M-300

DEPARTMENT OF DESIGN AND CONSTRUCTION SERVICES OFFICE OF INFRASTRUCTURE RENEWAL PROGRAM GROUP

APPROVED Mark W. 03/2018

MARK MAGNUSSEN DATE

MANAGER, ENV. PLANNING AND COMP

APPROVED 03/2018 M NO.

GRAHAM SPILLER
GFP DEPUTY PROGRAM MANAGER


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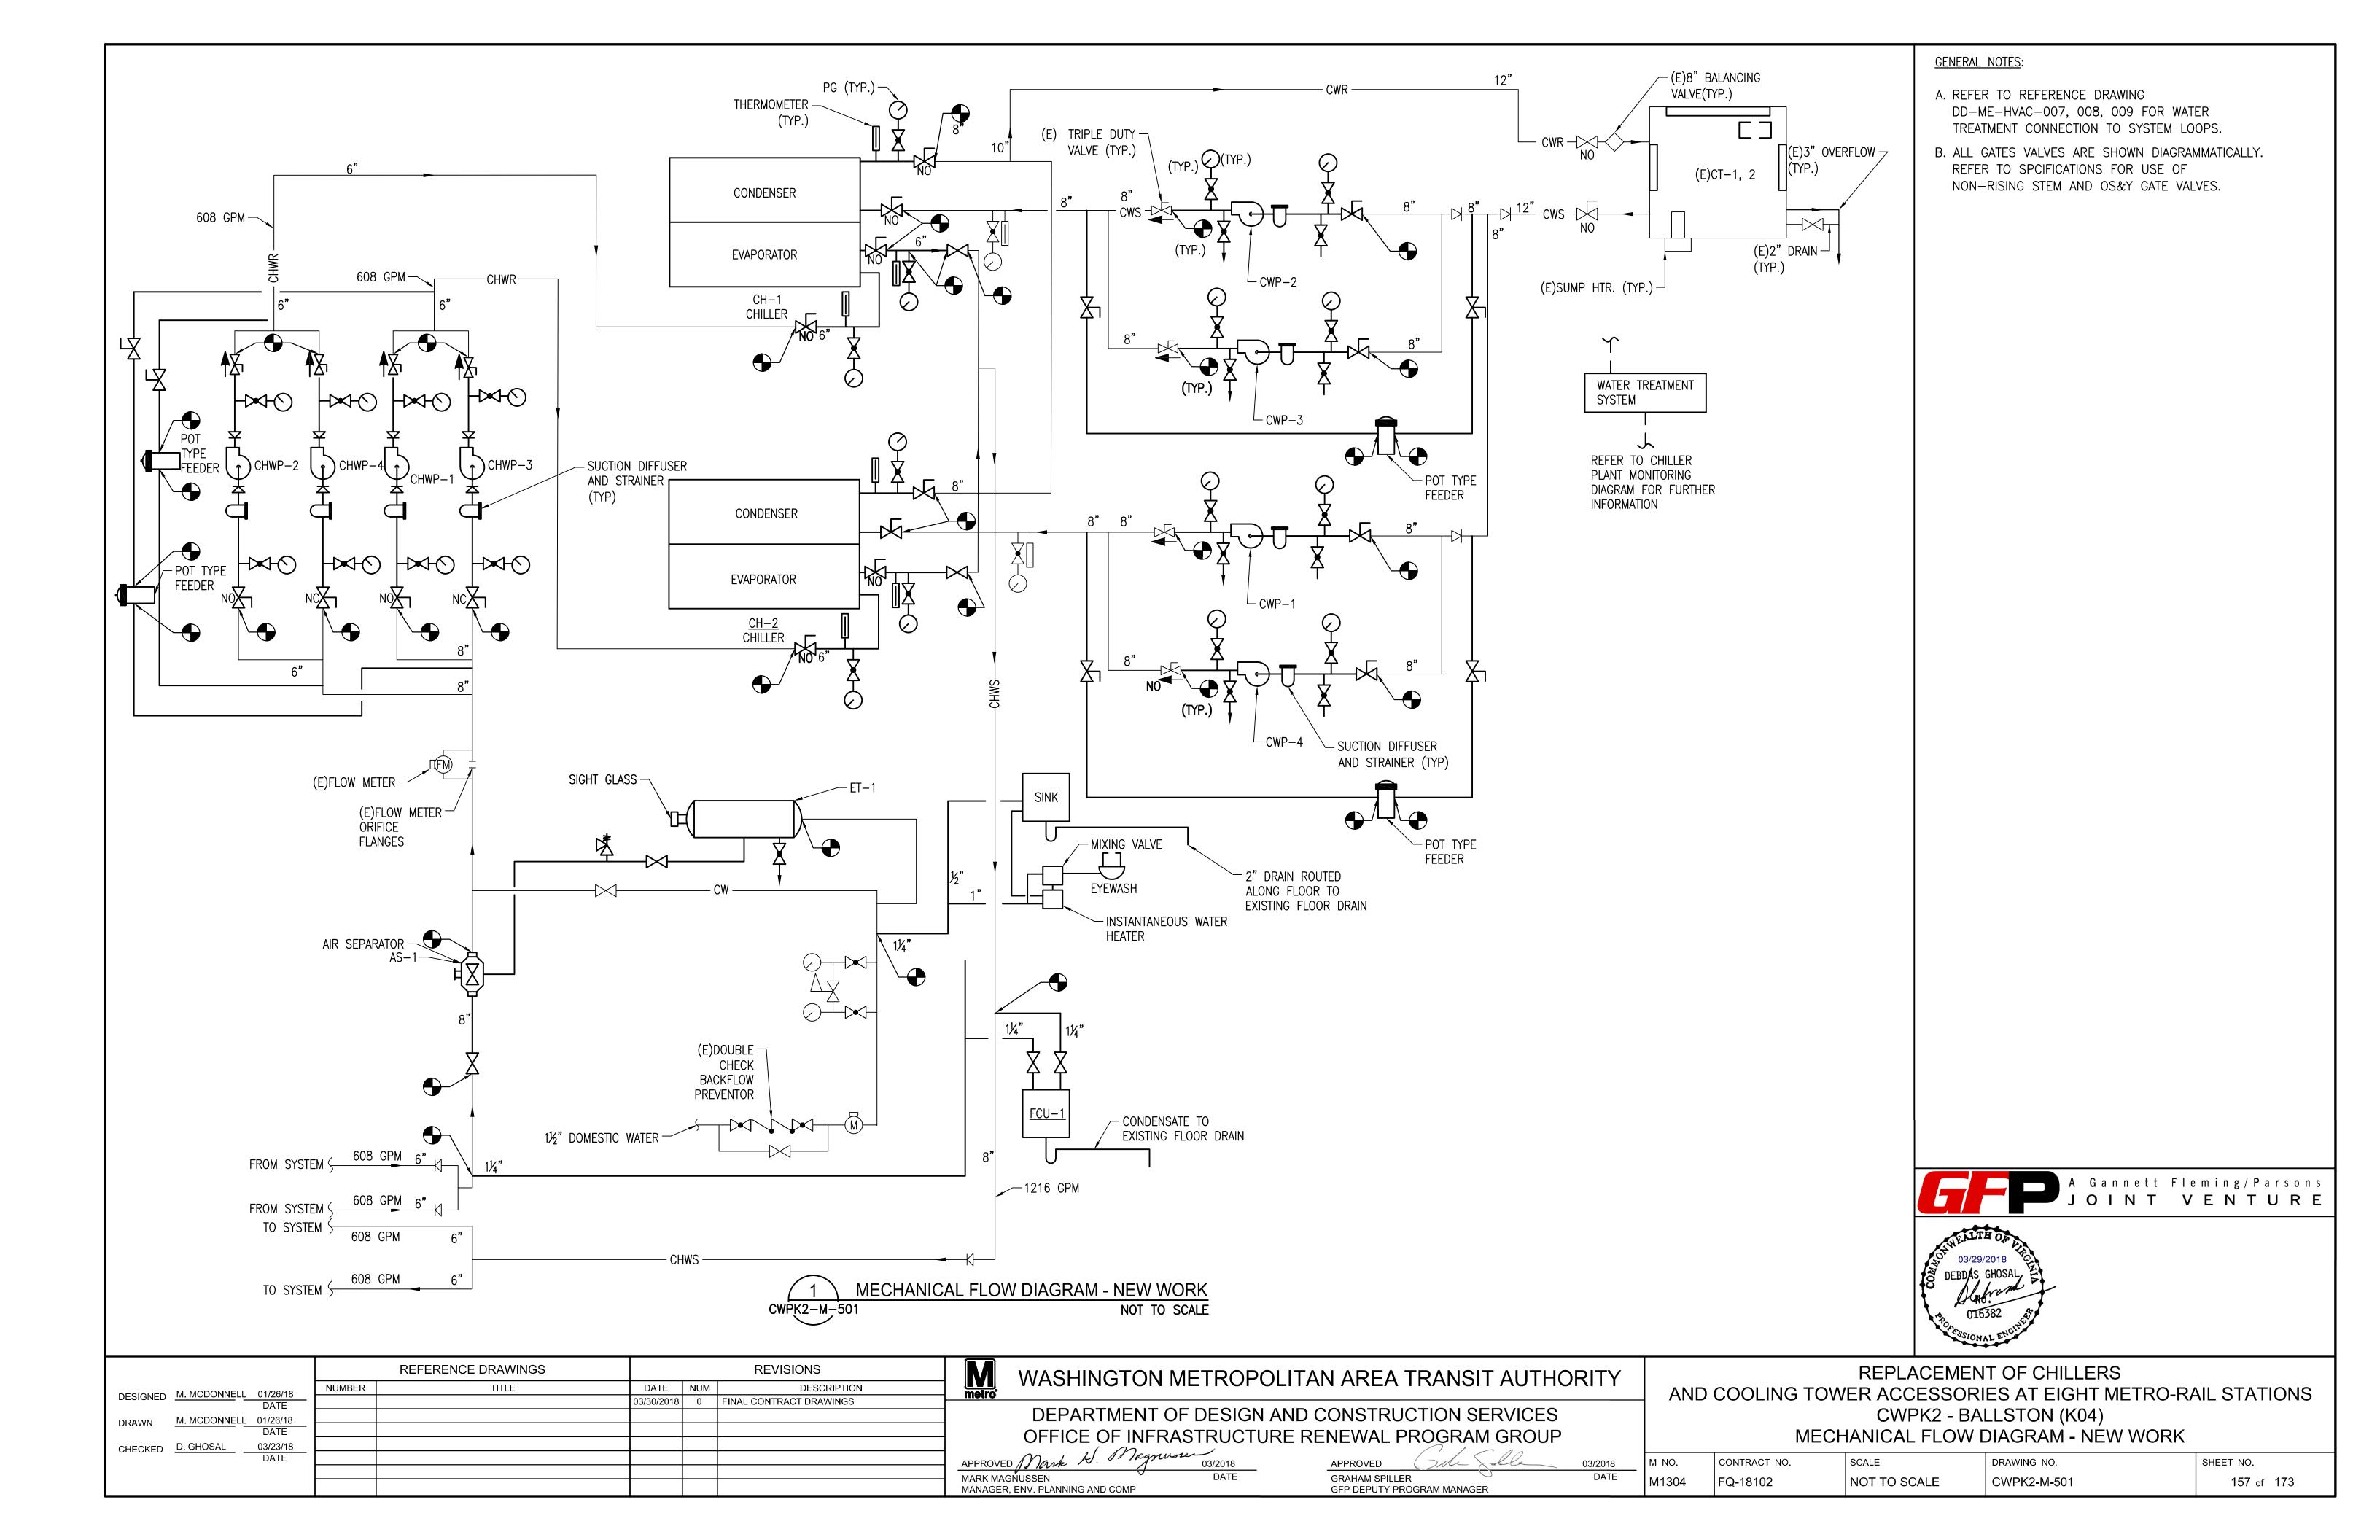
M1304

SECTION - NEW WORK

REPLACEMENT OF CHILLERS AND COOLING TOWER ACCESSORIES AT EIGHT METRO-RAIL STATIONS CWPK2 - BALLSTON (K04) MECHANICAL SECTIONS

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0.	CONTRACT NO.	SCALE	DRAWING NO.	SHEET NO.
304	FQ-18102	3/8" = 1'-0"	CWPK2-M-300	155 of 173



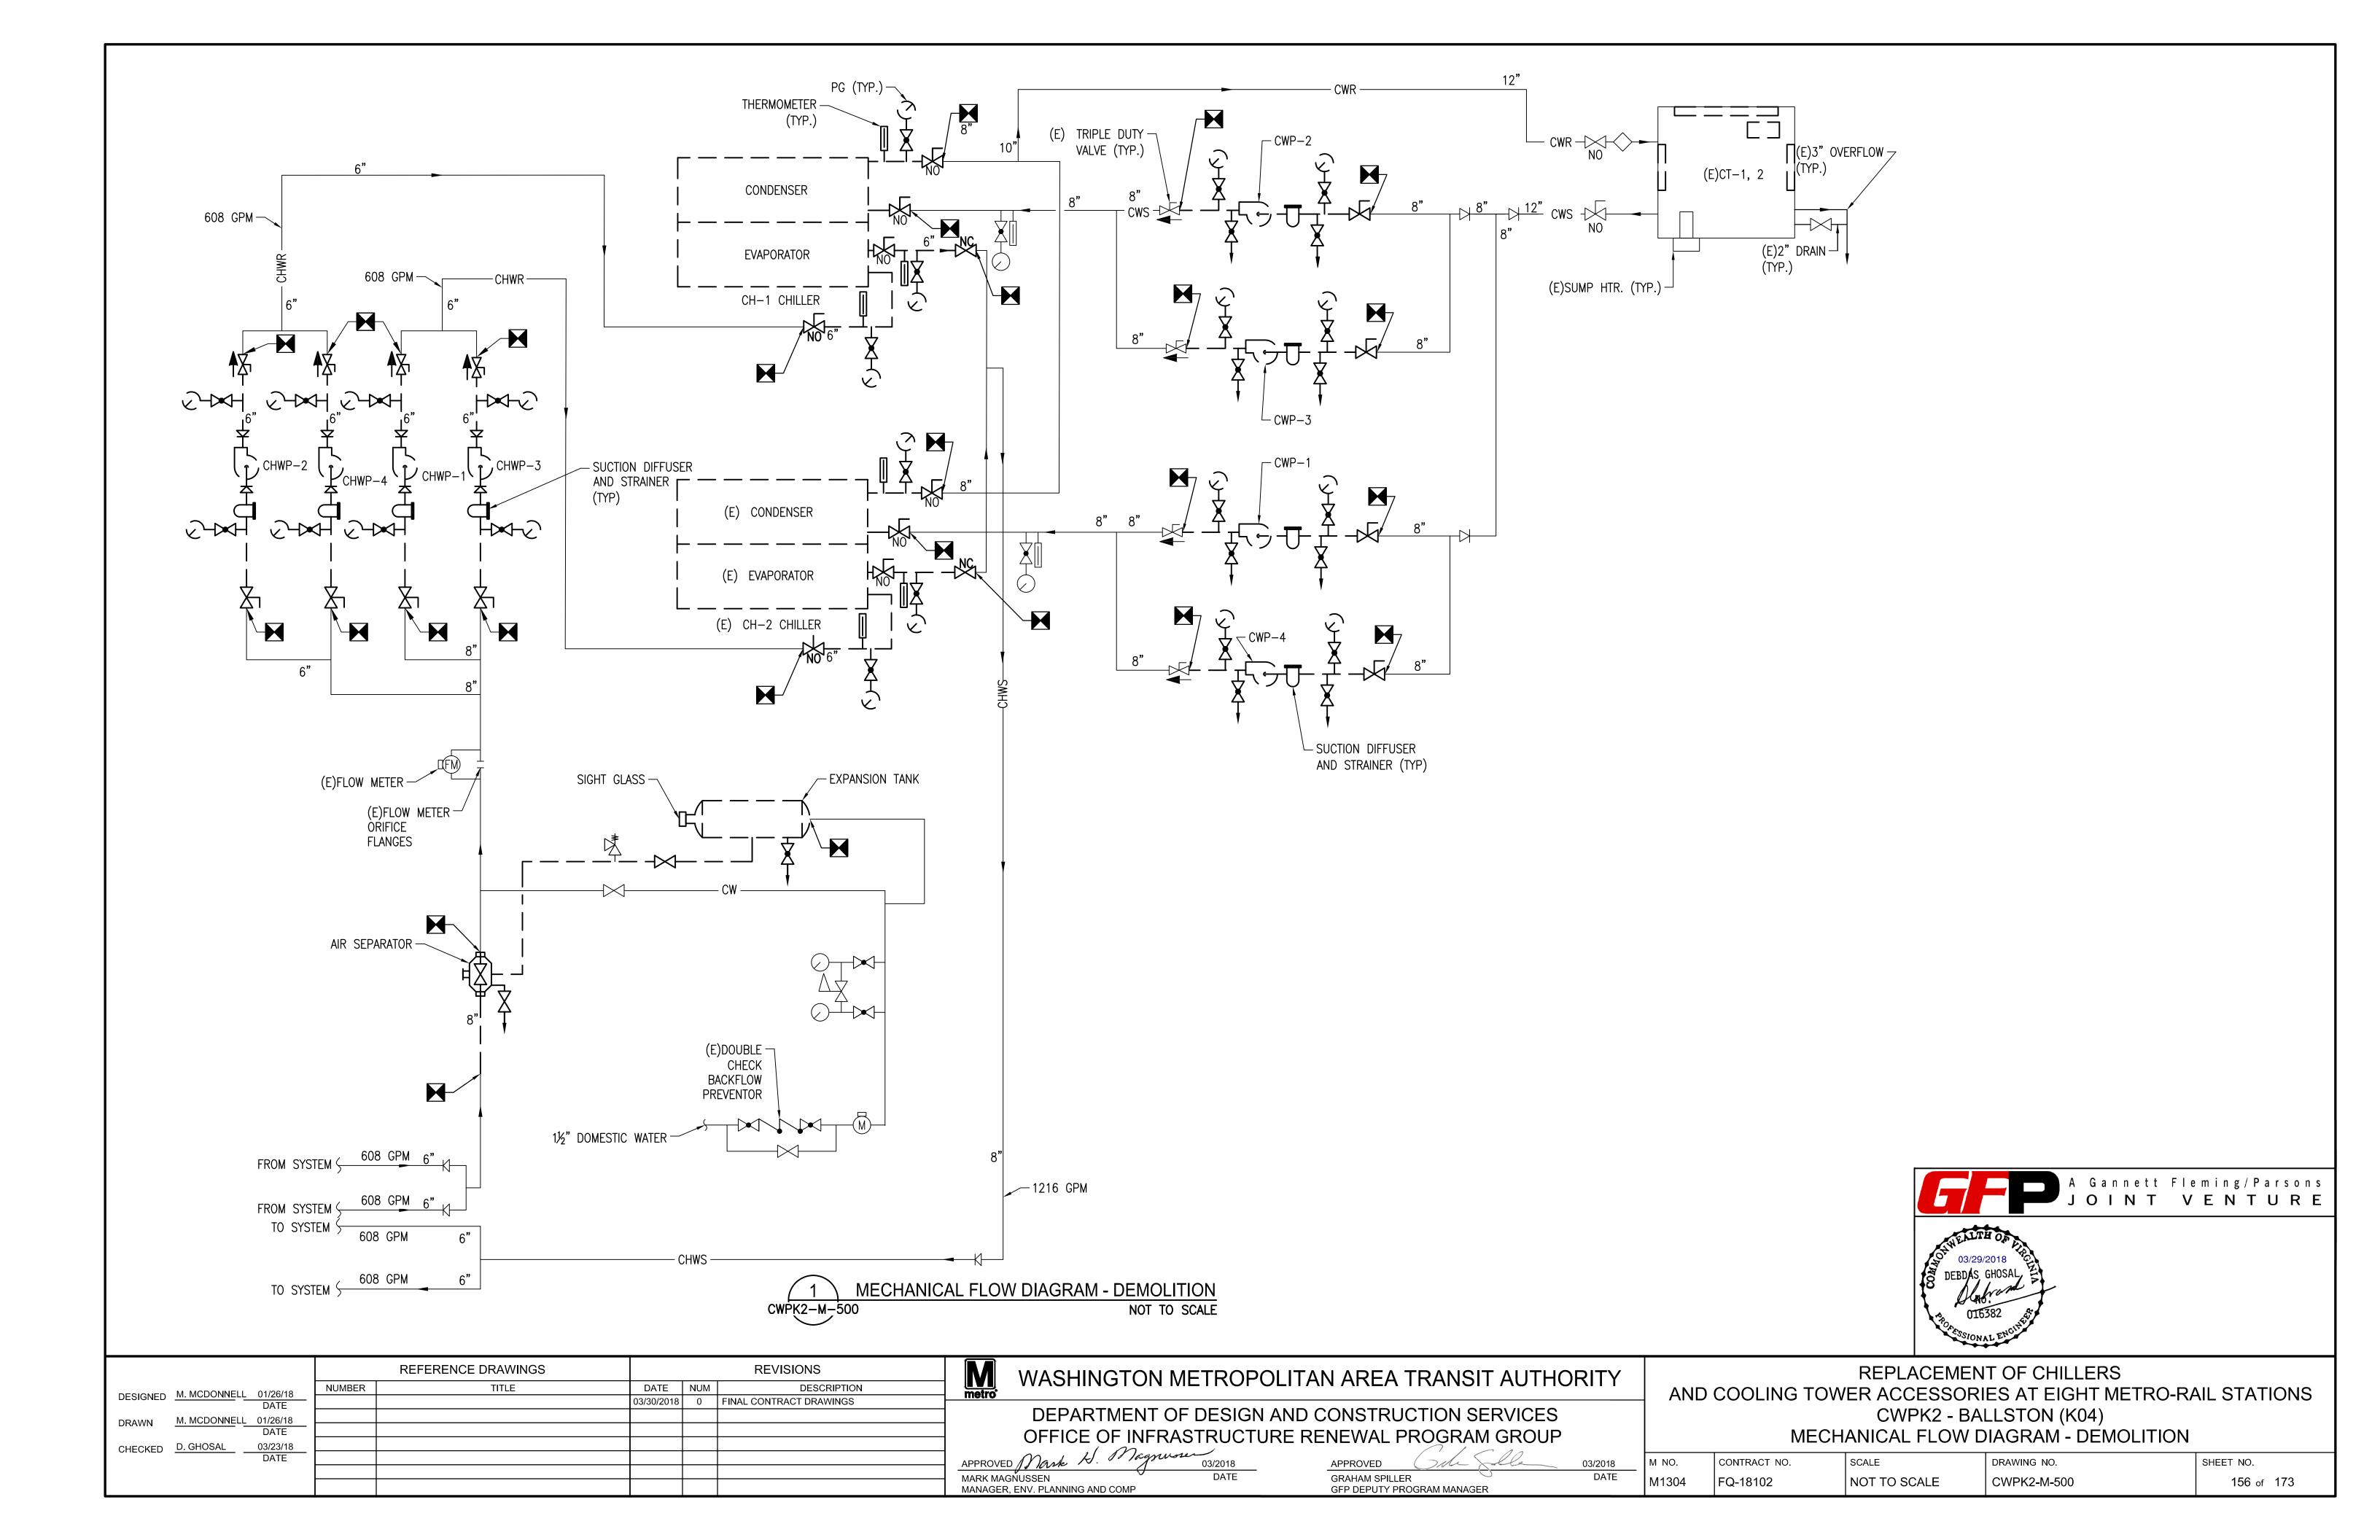

CHILLER SCHEDULE **EVAPORATOR** COMPRESSOR / CHILLER ELECTRICAL CONDENSOR CAPACITY MARK DESIGNATION BASIS OF DESIGN (TONS) EWT (F) LWT (F) LWT (F) GPM EWT (F) PASSES GPM PASSES **VOLTS** PHASE RLA MOCP MCA Hz LRA (FT H20) (FT H20) 608 990 CWPK04 CH-1330 55.00 42.00 12.00 85.00 95.00 19.00 460 DAIKIN WMC060DD DAIKIN WMC060DD CH-2330 55.00 42.00 990 95.00 19.00 60 298 164 450 335 CWPK04 608 12.00 85.00 460

NOTES:

- PROVIDE WITH NEOPRENE ISOLATION PADS.
- 2. PROVIDE WITH CHILLED WATER FLOW INDICATOR.
- WATER-COOLED, SEMI-HERMETIC OIL-FREE CENTRIFUGAL COMPRESSOR WATER CHILLER.
- TWO MAGNETIC BEARING, COMPLETELY OIL-FREE CENTRIFUGAL COMPRESSORS ON EACH CHILLER.
- 5. CHILLERS SHALL BE CHARGED WITH REFRIGERANT R-134A.
- 6. MOTORS SHALL BE LIQUID REFRIGERANT COOLED WITH INTERNAL THERMAL SENSING DEVICES IN THE STATOR WINDINGS.
- 7. THE CHILLER SHALL BE EQUIPPED WITH AN INTEGRATED VARIABLE FREQUENCY DRIVE (VFD) TO AUTOMATICALLY REGULATE COMPRESSOR SPEED IN RESPONSE TO COOLING LOAD AND THE COMPRESSOR PRESSURE LIFT REQUIREMENT, OPERATING CONTROLS AND EQUIPMENT PROTECTION CONTROLS.
- 8. CHILLER CONTROLS SHALL COORDINATE COMPRESSOR SPEED AND GUIDE VANE POSITION TO OPTIMIZE CHILLER EFFICIENCY.
- 9. CHILLER SHALL BE EQUIPPED WITH MICROTECH II CONTROLLER OR EQUIVALENT AND SHALL INCLUDE REMOTE COMMUNICATIONS CARDS WITH MODBUS RTU CAPABILITY, TO CONNECT THE I/O POINTS TO CHILLER PLANT MONITORING PANEL.
- 10. CHILLER CAPACITY BASED ON WATER.
- 11. CHILLER TOTAL OPERATING WEIGHT 13,079 LB
- 12. CHILLER DIMENSIONS 178.19 IN X 55.17 IN (FOOT PRINT)
- 13 PROVIDE FACH CHILLER WITH SINGLE POINT POWER CONNECTION

13. FROVIDE LACIT CHILL	J. FINOVIDE LACT CHILLEN WITH SINGLE FOINT FOWEN CONNECTION.													
	FAN COIL UNIT SCHEDULE													
	CAPACIT		EVAPORATOR							ELECTRICAL				
PLANT	DESIGNATION	(TONS)	GPM	ROWS	EWT (F)	LWT (F)	CFM	EAT (F) (DB/WB)	LAT (F) (DB/WB)	HP	VOLTS	PHASE	Hz	BASIS OF DESIGN
CWPK04	FCU-1	6	11.5	6	42.00	55.00	1870	80/67	55.7/54.5	0.75	115	1	60	DAIKIN HCBB120

NOTES:

- 1. FACTORY MOUNTED COIL, CONTROLS, MOTORS, DRIVE KITS.
- 2. PIPING PACKAGE WITH SINGLE 3-WAY MODULATING VALVE OPTION.

							Pl	JMP SC	HEDULE						
111517	SERVICE	7.05	0.514	FT	INLET	OUTLET	IMPELLER	OPERATING	FOOTPRINT			MOTOR			51010 05 5501011
MARK	SERVICE	TYPE	GPM	HEAD	(IN.)	(IN.)	DIA (IN.)	WEIGHT (LB)	(IN.)	RPM	HP	VOLTS	PH	Hz	BASIS OF DESIGN
CWP-1	CONDENSER WATER	CENTRIFUGAL	990	70	6	5	9.67	629	48x19	1780	25	460	3	60	ARMSTRONG 4030-6x5x10
CWP-2	CONDENSER WATER	CENTRIFUGAL	990	70	6	5	9.67	629	48x19	1780	25	460	3	60	ARMSTRONG 4030-6x5x10
CWP-3	CONDENSER WATER	CENTRIFUGAL	990	70	6	5	9.67	629	48x19	1780	25	460	3	60	ARMSTRONG 4030-6x5x10
CWP-4	CONDENSER WATER	CENTRIFUGAL	990	70	6	5	9.67	629	48x19	1780	25	460	3	60	ARMSTRONG 4030-6x5x10
CHWP-1	CHILLED WATER	CENTRIFUGAL	608	100	5	4	10.13	604	48x19	1780	25	460	3	60	ARMSTRONG 4030-5x4x10
CHWP-2	CHILLED WATER	CENTRIFUGAL	608	100	5	4	10.13	604	48x19	1780	25	460	3	60	ARMSTRONG 4030-5x4x10
CHWP-2	CHILLED WATER	CENTRIFUGAL	608	100	5	4	10.13	604	48x19	1780	25	460	3	60	ARMSTRONG 4030-5x4x10
CHWP-4	CHILLED WATER	CENTRIFUGAL	608	100	5	4	10.13	604	48x19	1780	25	460	3	60	ARMSTRONG 4030-5x4x10

- PROVIDE WITH INVERTER DUTY, PREMIUM EFFICIENCY AND VFD COMPATIBLE MOTOR.
- PROVIDE WITH SPRING TYPE ISOLATION.
- 3. PROVIDE WITH SUCTION DIFFUSER AND INTEGRAL STRAINER AT INLET OF PUMPS AND ECCENTRIC REDUCER/INCREASER AT PUMP INLET/OUTLET FOR ALL PUMPS.

	EXISTING COOLING TOWER SCHEDULE														
MARK	SERVICE	TYPE	GPM	EWT (F)	LWT (F)	AMB. AIR WET BULB TEMP. (F)		CFM	NO. OF MOTORS	FAN HP	V	PH	Hz	OPERATING WEIGHT (LB)	EXISTING MODEL NO.
(E) CT-1, 2	CONDENSER WATER	AXIAL	990	95	85	78	1	95800	1	20	460	3	60	18500	EVAPCO USS-29-924

- SEPARATE STARTER PANELS FURNISHED FOR FIELD MOUNTING.
- PROVIDE DIRECT DRIVE FAN WITH INVERTER DUTY MOTORS.
- COOLING TOWER FAN MOTORS SHALL BE RATED VFD COMPATIBLE.
- PROVIDE WITH NEW LOUVERS FOR EXISTING COOLING TOWERS. 5. PROVIDE WITH NEW PLASTIC FILL FOR EXISTING COOLING TOWERS.
- REFERENCE DRAWINGS REVISIONS DESCRIPTION DATE NUM DESIGNED M. MCDONNELL 01/26/18 03/30/2018 0 FINAL CONTRACT DRAWINGS M. MCDONNELL 01/26/18 CHECKED D. GHOSAL 03/23/18
 DATE

WASHINGTON METROPOLITAN AREA TRANSIT AUTHORITY

DEPARTMENT OF DESIGN AND CONSTRUCTION SERVICES OFFICE OF INFRASTRUCTURE RENEWAL PROGRAM GROUP

MARK MAGNUSSEN MANAGER, ENV. PLANNING AND COMP

03/2018 GRAHAM SPILLER M1304 GFP DEPUTY PROGRAM MANAGER

REPLACEMENT OF CHILLERS AND COOLING TOWER ACCESSORIES AT EIGHT METRO-RAIL STATIONS CWPK2 - BALLSTON (K04)

CWPK2-M-600


MECHANICAL EQUIPMENT SCHEDULES - SHEET 1 OF 2 M NO. CONTRACT NO. SCALE DRAWING NO. SHEET NO.

NONE

FQ-18102

A Gannett Fleming/Parsons JOINT VENTURE

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FLOW MONITORING SYSTEM

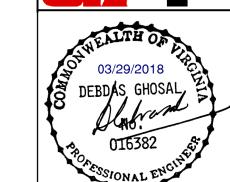3. ACCURACY: 1% OF VELOCITY

6. BUILT-IN FLOW TOTALIZERS

OUTPUT, ALARM OUTPUT

TERMINATION POINTS.

REFRIGERANT LEAK DETECTION SYSTEM

WMATA CONTRACT FQ14114.

CHILLER PLANT CONTROL PANEL.

10. PIPE SIZE RANGE, 6"

4. NO DEPENDENCY ON CONDUCTIVITY

2. MAINTENANCE-FREE

VARIATIONS

1. NON-INTRUSIVE CLAMP-ON FLOW SENSORS

IN CHILLER PLANT MONITORING PANEL

11. NEMA 4X (IP55 OR BETTER) ENCLOSURE

9. SELF-EXPLANATORY MENU-DRIVEN PROGRAMMING

5. AUTOMATICALLY ADAPT TO PIPE MATERIAL AND LIQUID PROPERTY

7. ISOLATED RS-485 INTERFACE WITH POWER SURGE PROTECTION.

8. INPUT/OUTPUT, ISOLATED 4-20MA OUTPUT, RELAY, PULSE

12. SIEMENS SITRANS FUS 1010 (OR APPROVED EQUAL).

PROVIDE CABLES OF SUFFICIENT LENGTH TO REACH ALL

1. REFRIGERANT LEAK DETECTION SYSTEM INSTALLED AS PART OF

2. PROVIDE RS-485 ETHERNET CONNECTION TO CONNECT TO THE

SUPPORTS THE MODBUS PROTOCOL - CONNECT TO PAC 3000

	AIR SEPARATOR SCHEDULE											
MARK	DESIGNATION	ORIENTATION	GPM	MAX. WORKING PRESSURE (PSIG)	MAX. WORKING TEMP. (F)	SYSTEM SERVED	INLET & OUTLET SIZE (IN.)	DRY WEIGHT (LB)	BASIS OF DESIGN			
AS-1	CHILLER PLANT	VERTICAL	1,216	165	375	CHILLED WATER	8"	332	ARMSTRONG VAS-8			

NOTES:

- 1. PROVIDE WITH FABRICATED STEEL SHELL.
- 2. PROVIDE WITH BLOW DOWN CONNECTION.
- 3. PROVIDE WITH STAINLESS STEEL STRAINER.

	EXPANSION TANK SCHEDULE											
MARK	LOCATION	EQUIP. SERVED	TYPE	ORIENTATION	INITIAL FILL	TANK VOLUME	SI	ZE (IN.)	WEIGHT (LB)	BASIS OF DESIGN		
			· · · · -		(PSIG)	(GAL.)	DIA	LENGTH	(==)	5,,6,6		
ET-1	CHILLER PLANT	CHILLED WATER	COMPRESSION	HORIZONTAL	12	505	36	120	810	ARMSTRONG AET 36x120		

NOTES:

1. PROVIDE SADDLES WITH EXPANSION TANK.


UNIT HEATER SCHEDULE														
MARK	LOCATION	7./05		ELECTRICAL DATA				HORIZ. AIR	WIDTH	HEIGHT	DEPTH	WEIGHT		
		TYPE	kW	MOTOR HP	VOLT	PH	Hz	Hz MOTOR THROW (IN.)	(IN.)	(IN.)	(LB)	BASIS OF DESIGN		
UH-12	CHILLER PLANT	ELECTRIC, SUSPENDED	20	.05	480	3	60	1550	32	21.5	28.70	6.5	85	TRANE UHEC-203DACA

NOTES:

- 1. UNIT INSTALLED MOTOR STARTER.
- 2. DISCONNECT: FACTORY INSTALLED.
- 3. WALL/CEILING MOUNTED BRACKET. 4. WALL' MOUNT THERMOSTAT KIT.

VALVE SCHEDULE										
TYPE	SIZE (IN.)	SIZE (IN.) QUANTITY SEF		BASIS OF DESIGN	MODEL					
OS&Y GATE VALVE	6	8	CONDENSER WATER	NIBCO	F-617-0N					
TRIPLE DUTY VALVE	6	4	CHILLED WATER	BELL & GOSSETT	3DS-6S					
OS&Y GATE VALVE	6	4	CONDENSER WATER	NIBCO	F-617-0N					
OS&Y GATE VALVE	6	4	CHILLED WATER	NIBCO	F-617-0N					

	INSTANTANEOUS WATER HEATER SCHEDULE								
MARK	INLET SIZE (IN.)	TURN ON FLOW (GPM)	kW	AMPS	MAX. TEMPERATURE (F)	BASIS OF DESIGN	NOTES		
IWH-1	1/2	0.3	2.4	20	90	EEMAX EX2412T	SEE NOTE 1		
NOTES: 1. PROVIDE WITH THE									

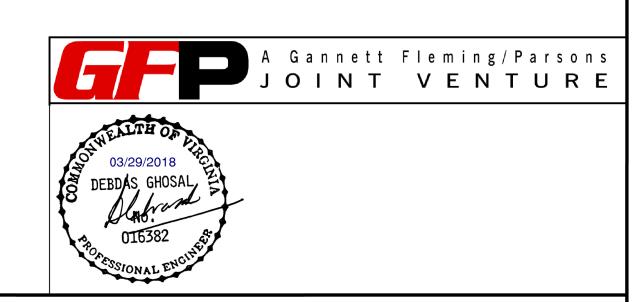

			REFERENCE DRAWINGS			REVISIONS			
DEGIONES M	M. MCDONNELL 0	01/26/18	NUMBER	TITLE	DATE	NUM	DESCRIPTION	1 .	
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WASHINGTON METROPOLITAN AREA TRANSIT AUTHORITY

DEPARTMENT OF DESIGN AND CONSTRUCTION SERVICES OFFICE OF INFRASTRUCTURE RENEWAL PROGRAM GROUP

APPROVED Mark M. Magnusur 03/2018

MARK MAGNUSSEN DATE

APPROVED

GRAHAM SPILLER

GRAHAM SPILLER

MANAGER, ENV. PLANNING AND COMP

APPROVED COLOR OF THE STREET O

REPLACEMENT OF CHILLERS
AND COOLING TOWER ACCESSORIES AT EIGHT METRO-RAIL STATIONS
CWPK2 - BALLSTON (K04)
MECHANICAL EQUIPMENT SCHEDULES - SHEET 2 OF 2

MECHANICAL EQUIPMENT SCHEDULES - SHEET 2 OF 2									
M NO.	CONTRACT NO.	SCALE	DRAWING NO.	SHEET NO.					
M1304	FQ-18102	NONE	CWPK2-M-601	159 of 173					